


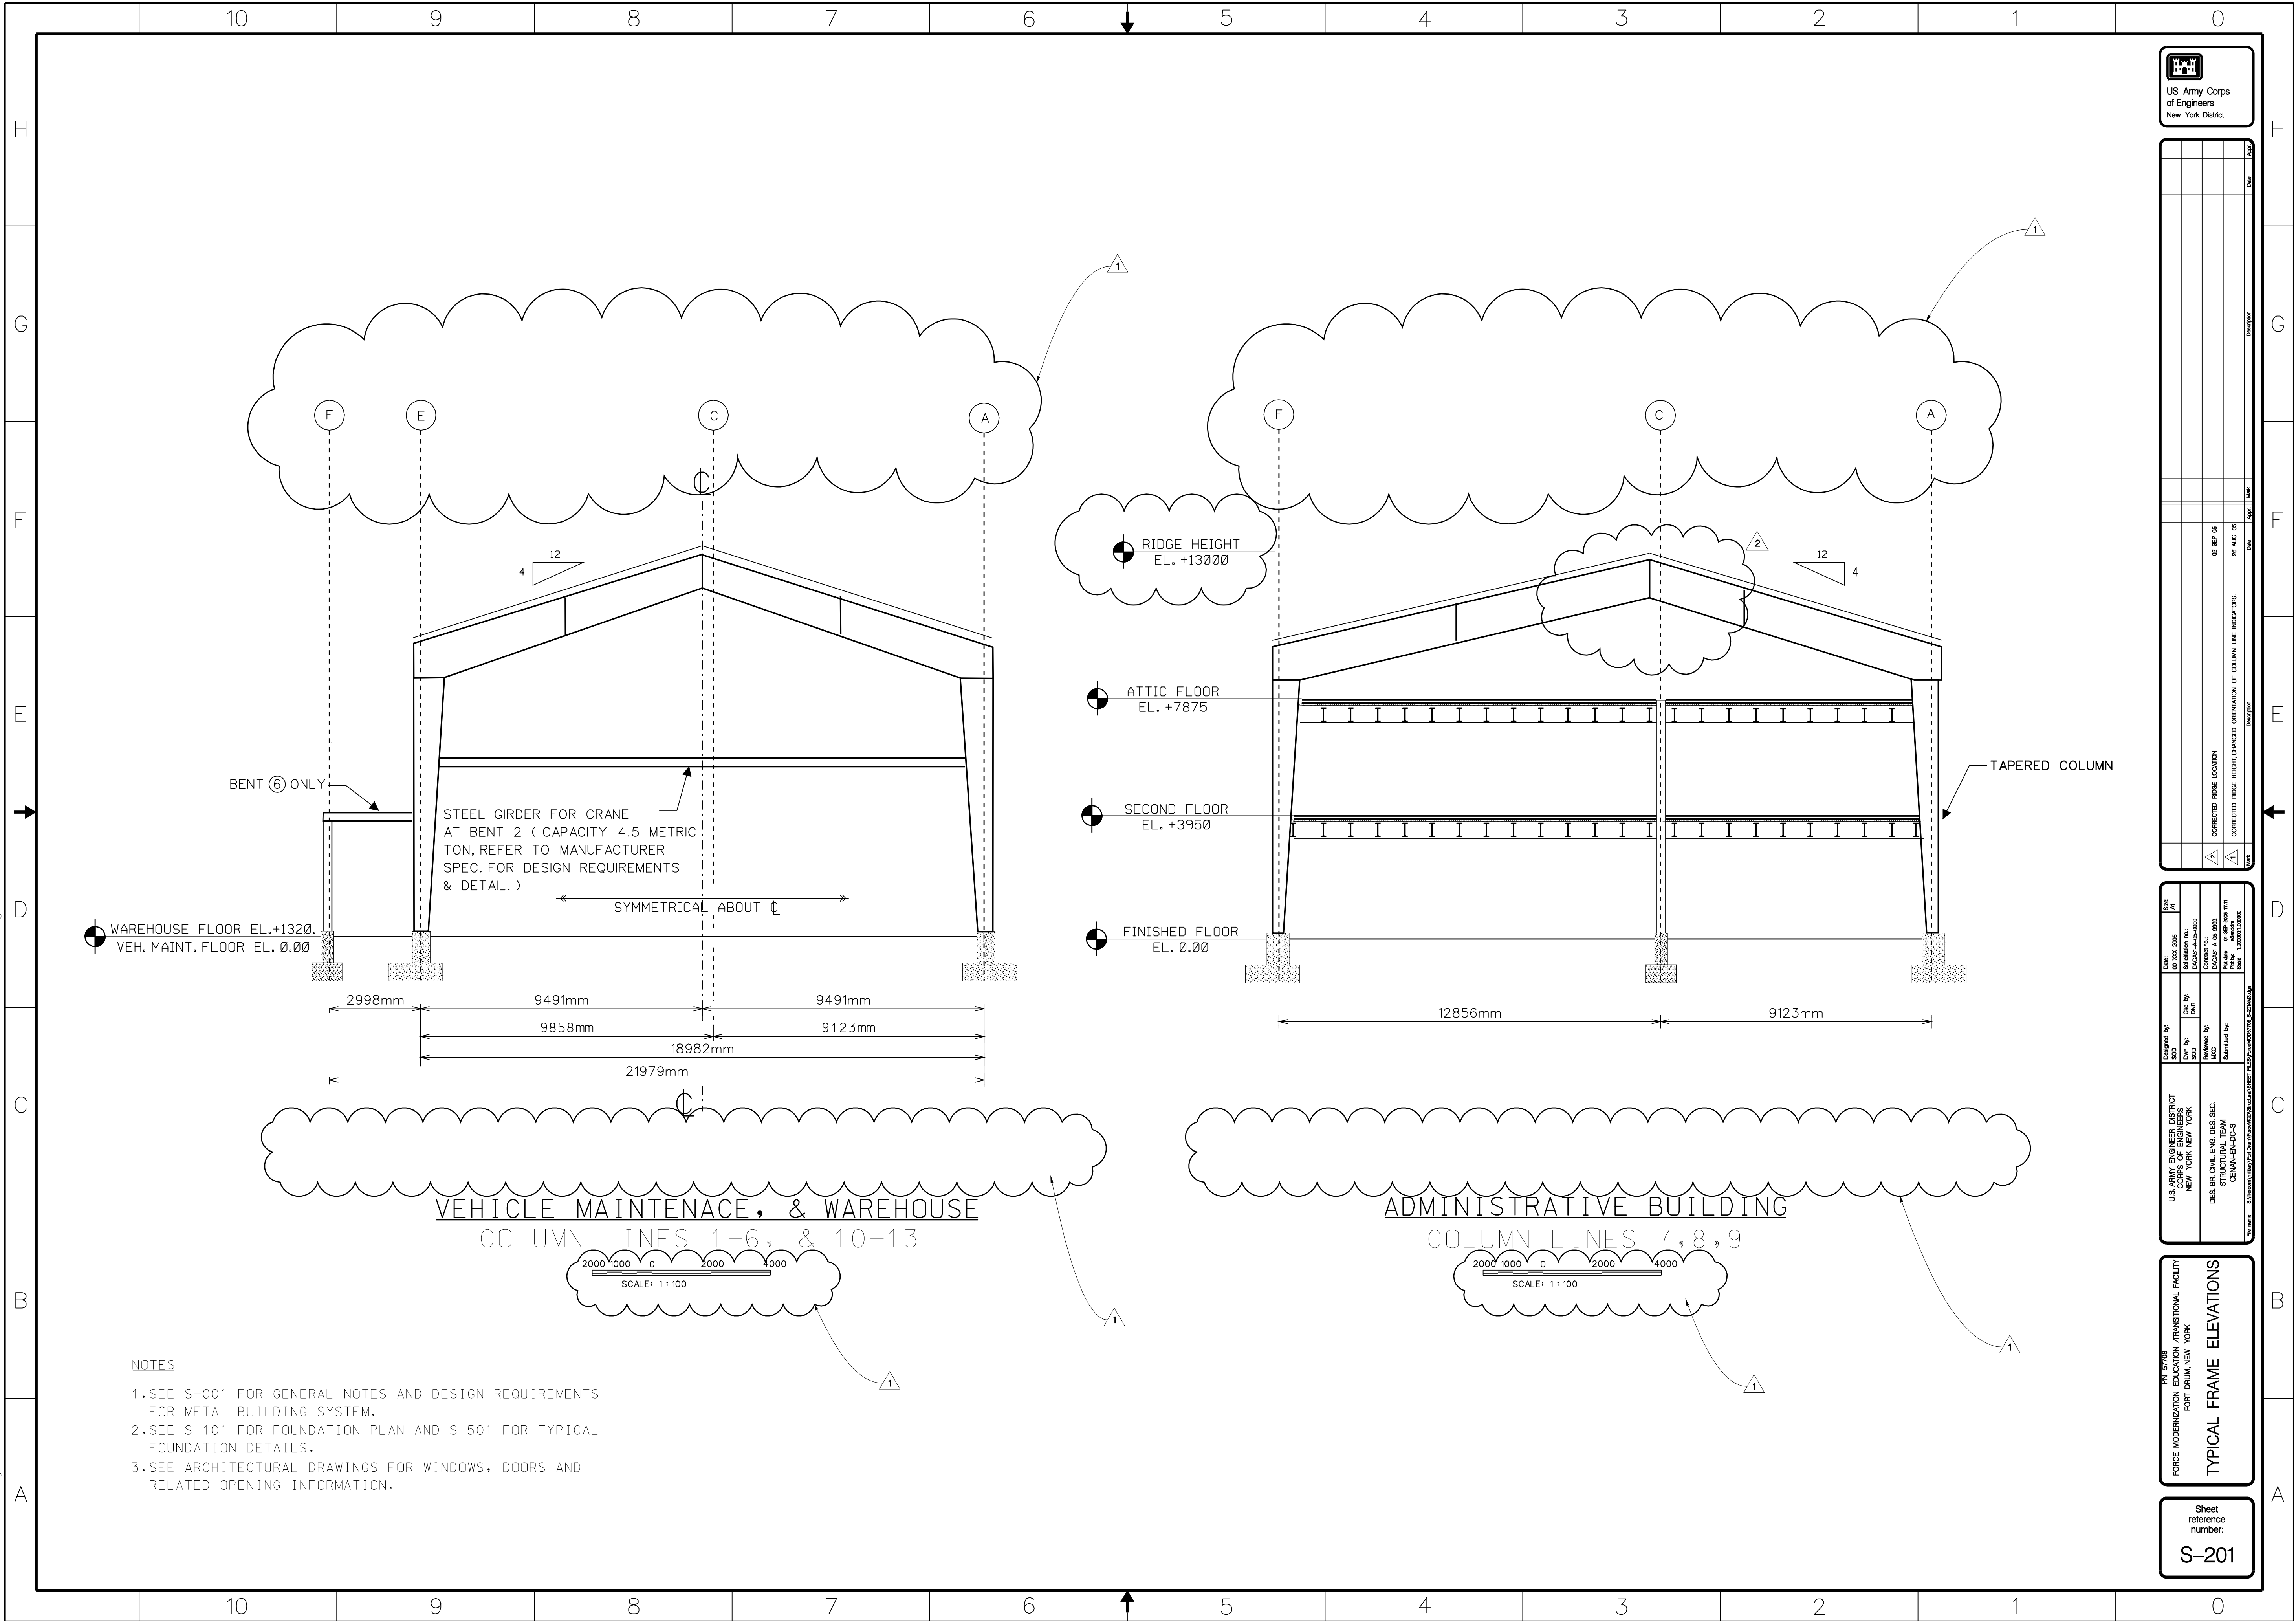

SPECIAL NOTE FOR DIMENSIONS WITH ASTERISK:

CONTRACTOR SHALL VERIFY THOSE DIMENSIONS AND ADJUST THEM AS NECESSARY
ACCORDING TO THE FOLLOWING TWO CRITERIA:










1. THE BUILDING ENVELOPE DIMENSIONS AS SHOW ON A-100 & A-101 SHALL REMAIN.
2. THE DISTANCE FROM CENTERLINE OF COLUMN TO FACE OF EXTERIOR WALL IS TO BE DETERMINED PER FINAL PRE-ENGINEERED METAL BUILDING DESIGN.




Rev	Date	Description
1	02 SEP 05	CORRECTED ROOF HEIGHT
2	02 SEP 05	CORRECTED ROOF HEIGHT
3	02 SEP 05	CORRECTED ROOF HEIGHT
4	02 SEP 05	CORRECTED ROOF HEIGHT
5	02 SEP 05	CORRECTED ROOF HEIGHT
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7	02 SEP 05	CORRECTED ROOF HEIGHT
8	02 SEP 05	CORRECTED ROOF HEIGHT
9	02 SEP 05	CORRECTED ROOF HEIGHT
10	02 SEP 05	CORRECTED ROOF HEIGHT
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12	02 SEP 05	CORRECTED ROOF HEIGHT
13	02 SEP 05	CORRECTED ROOF HEIGHT
14	02 SEP 05	CORRECTED ROOF HEIGHT
15	02 SEP 05	CORRECTED ROOF HEIGHT
16	02 SEP 05	CORRECTED ROOF HEIGHT
17	02 SEP 05	CORRECTED ROOF HEIGHT
18	02 SEP 05	CORRECTED ROOF HEIGHT
19	02 SEP 05	CORRECTED ROOF HEIGHT
20	02 SEP 05	CORRECTED ROOF HEIGHT

Rev	Date	Description
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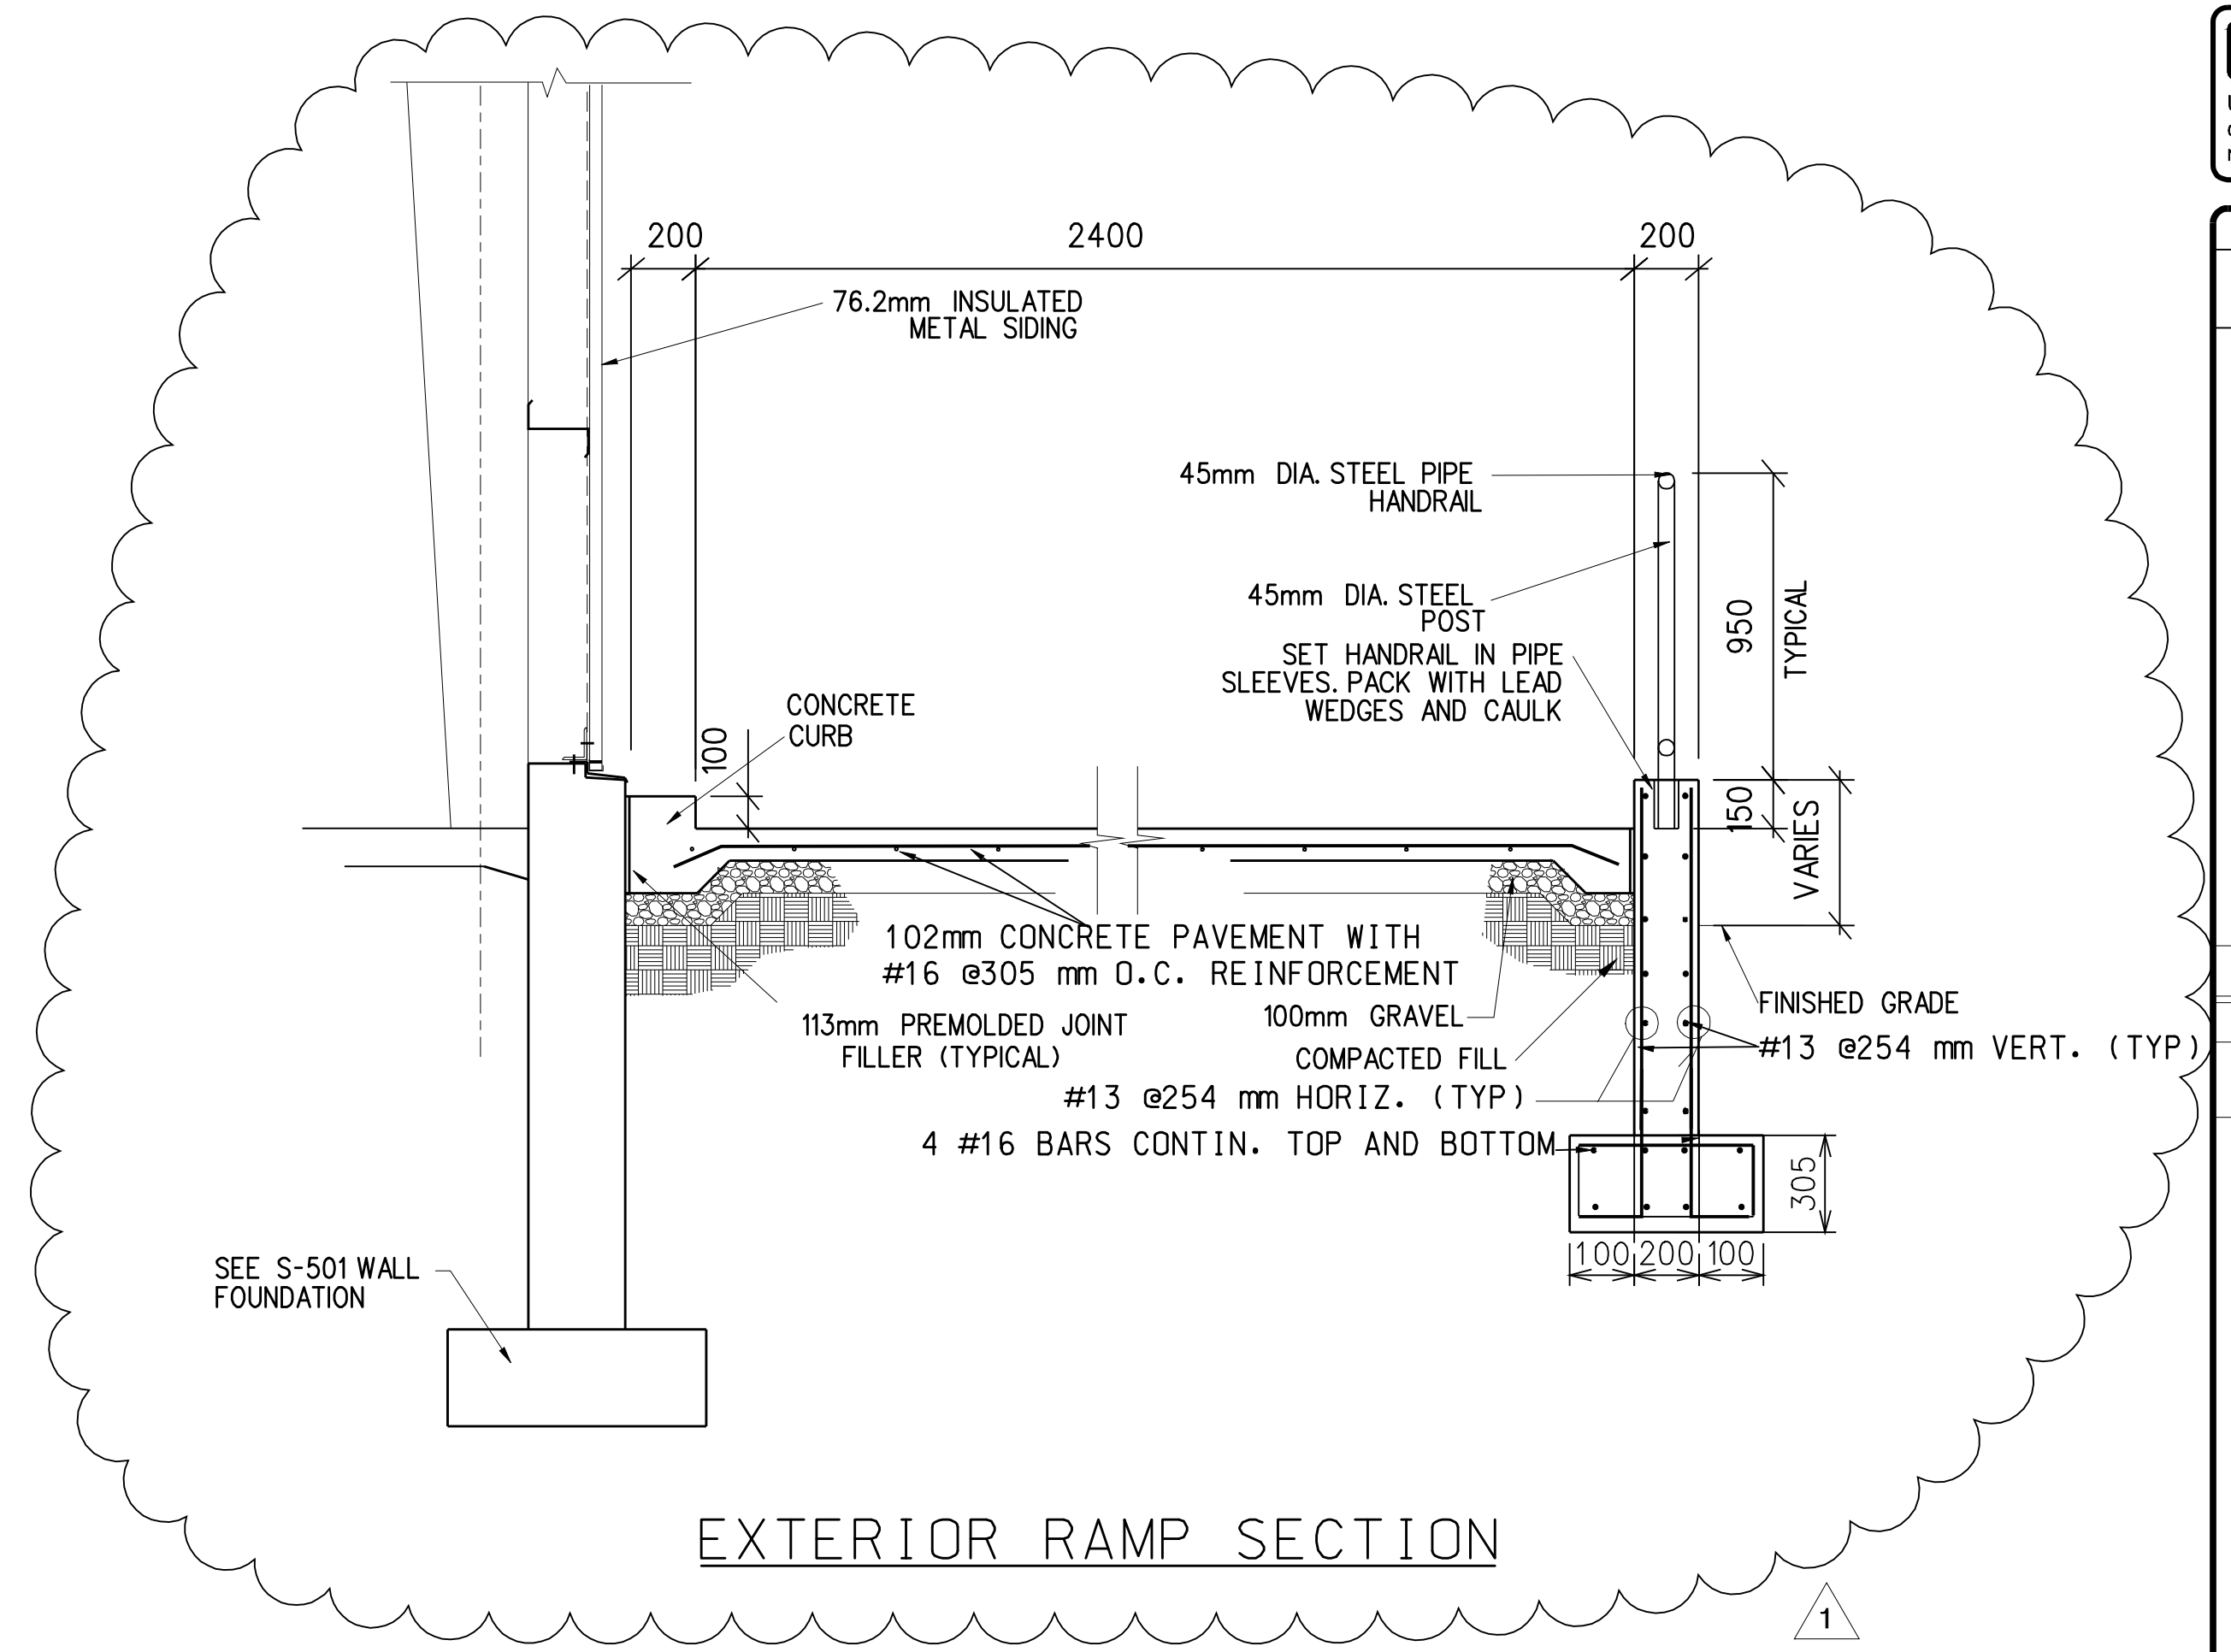
Rev	Date	Description
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4	02 SEP 05	CORRECTED ROOF HEIGHT
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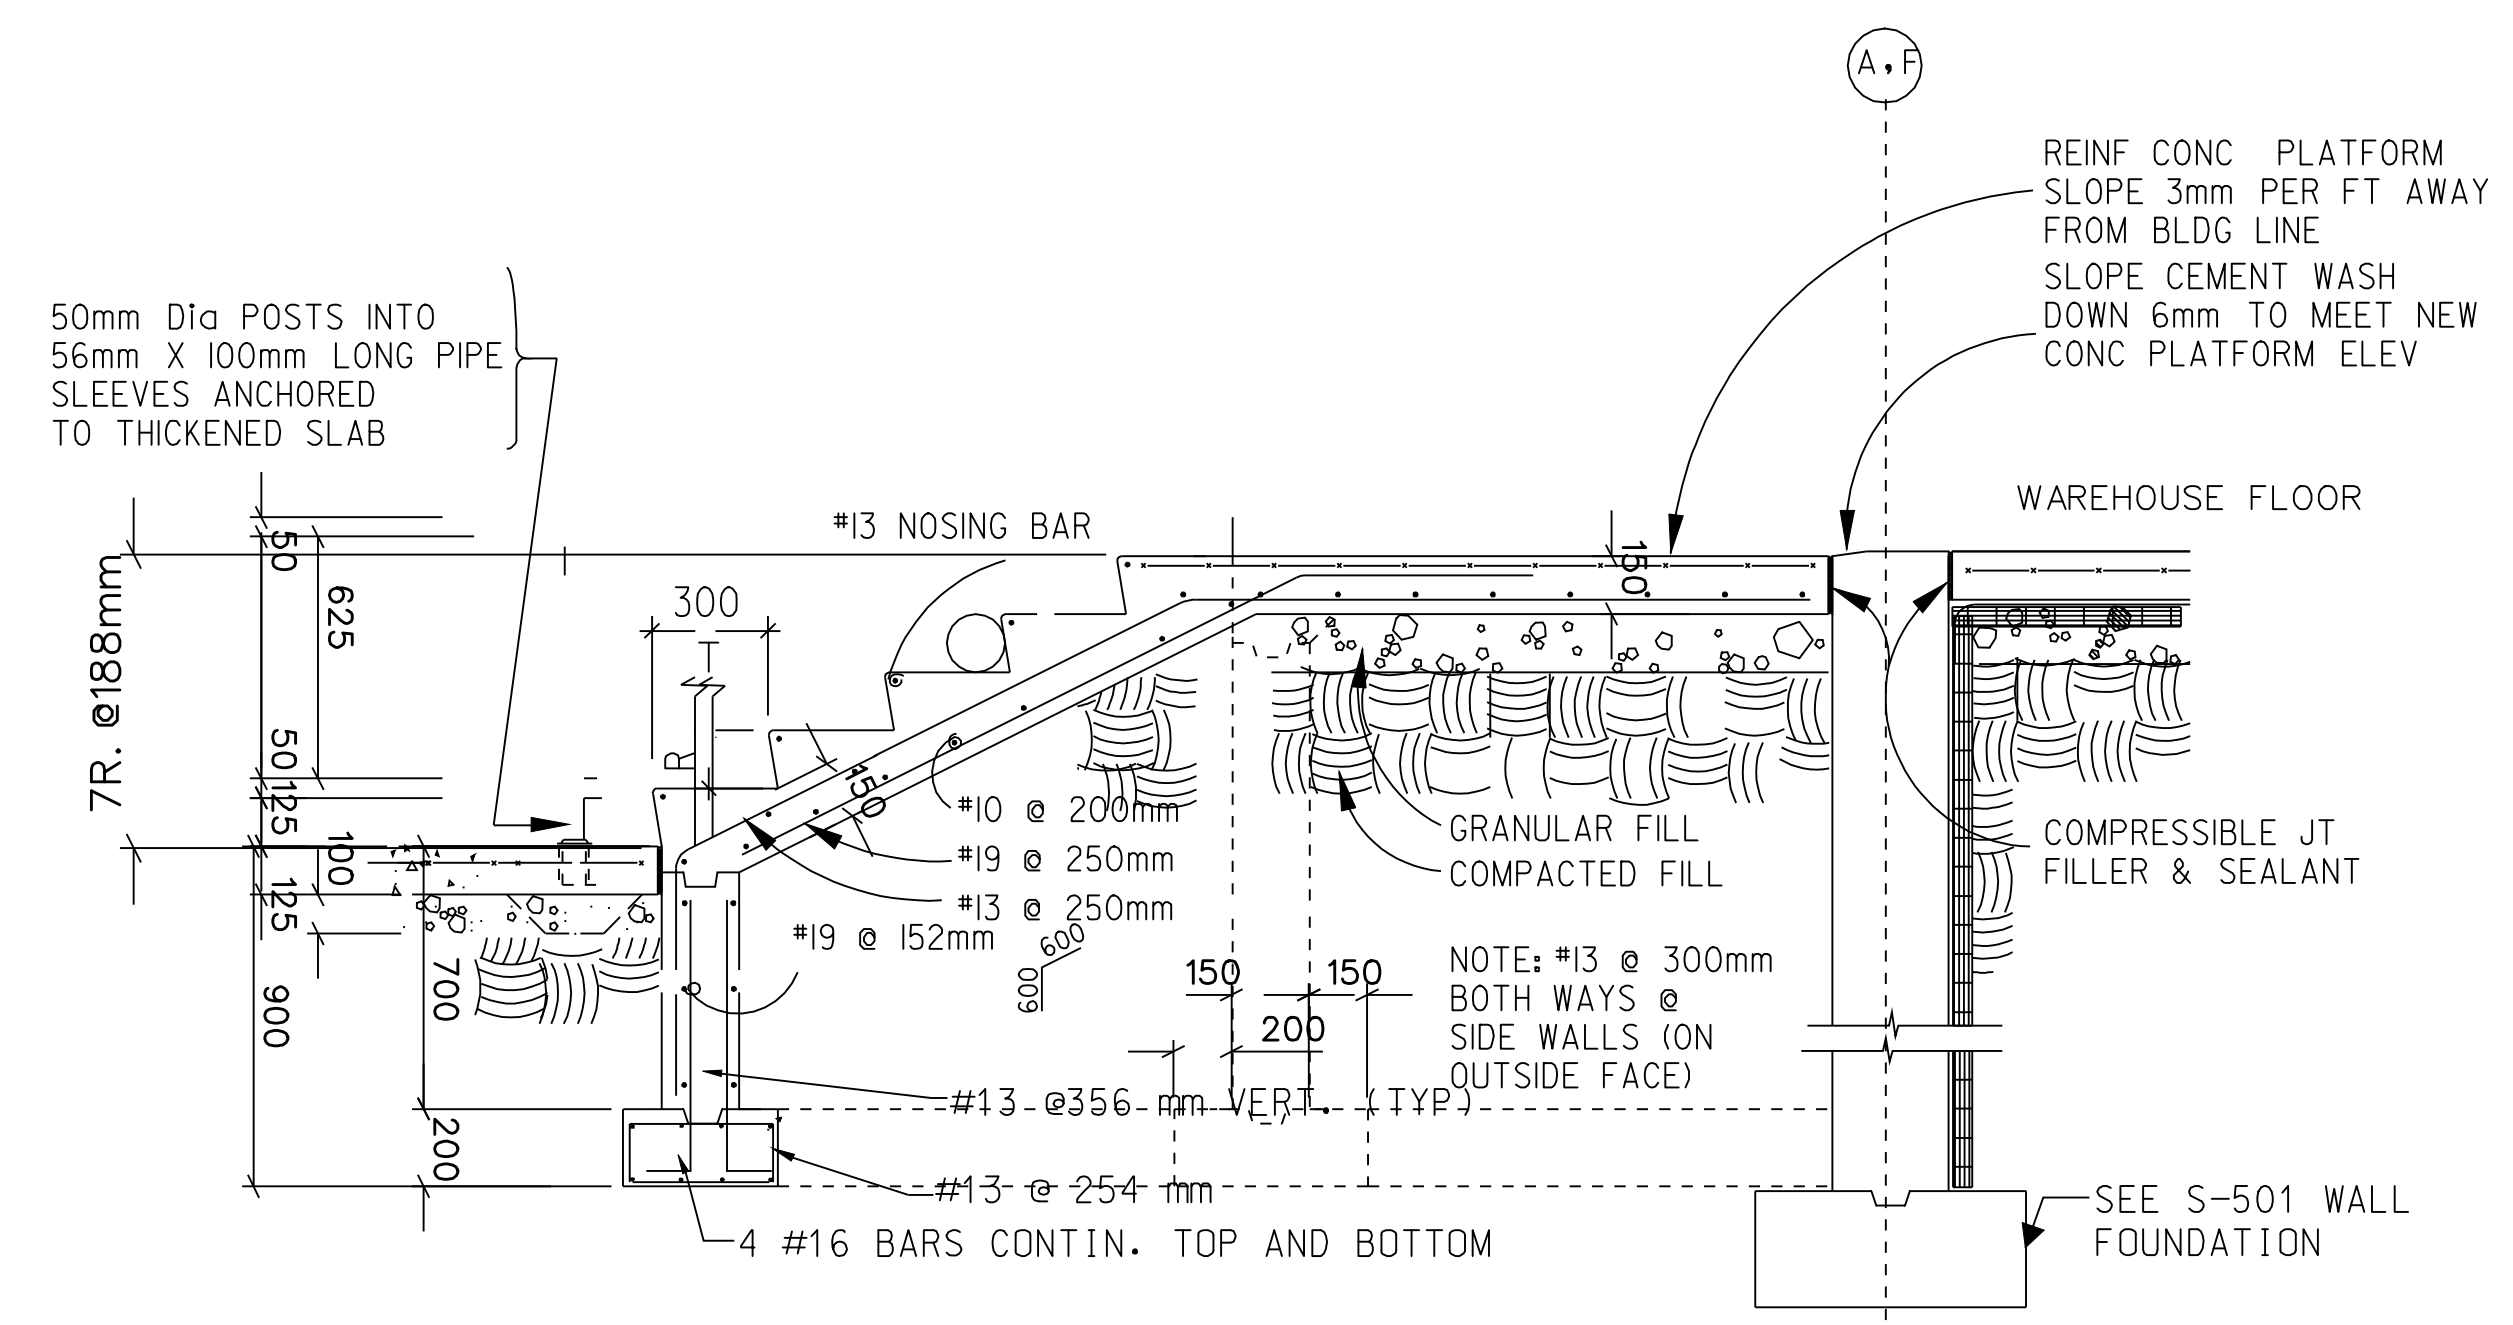
Submitted by: e3enddmr S:\filteroommilitary\Fort Drum\FortCoeMOD057708_S-SB502A.dgn Plot Date: 01-SEP-2005 17:02

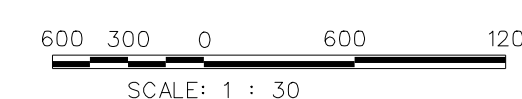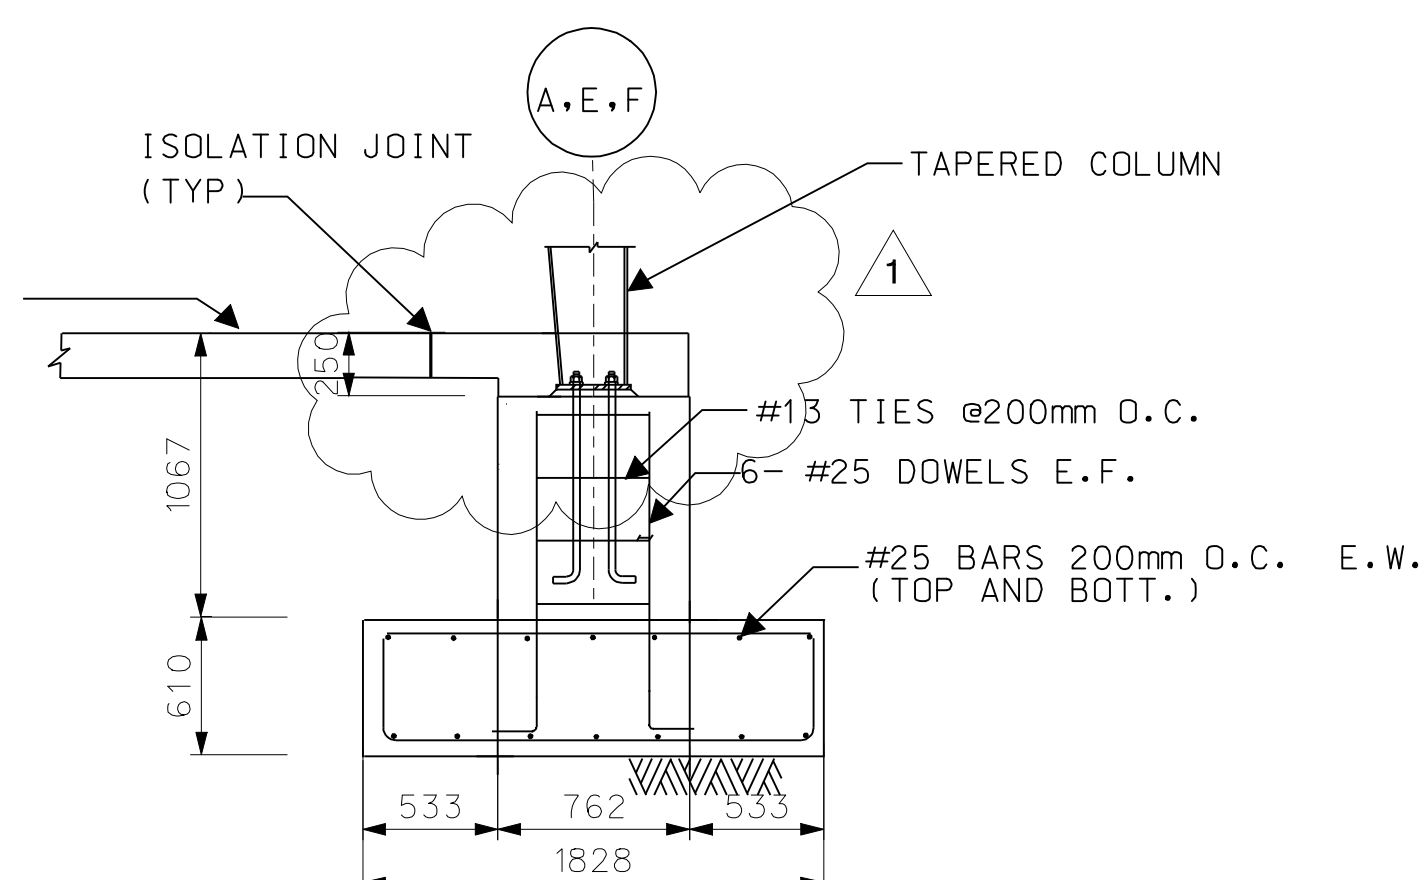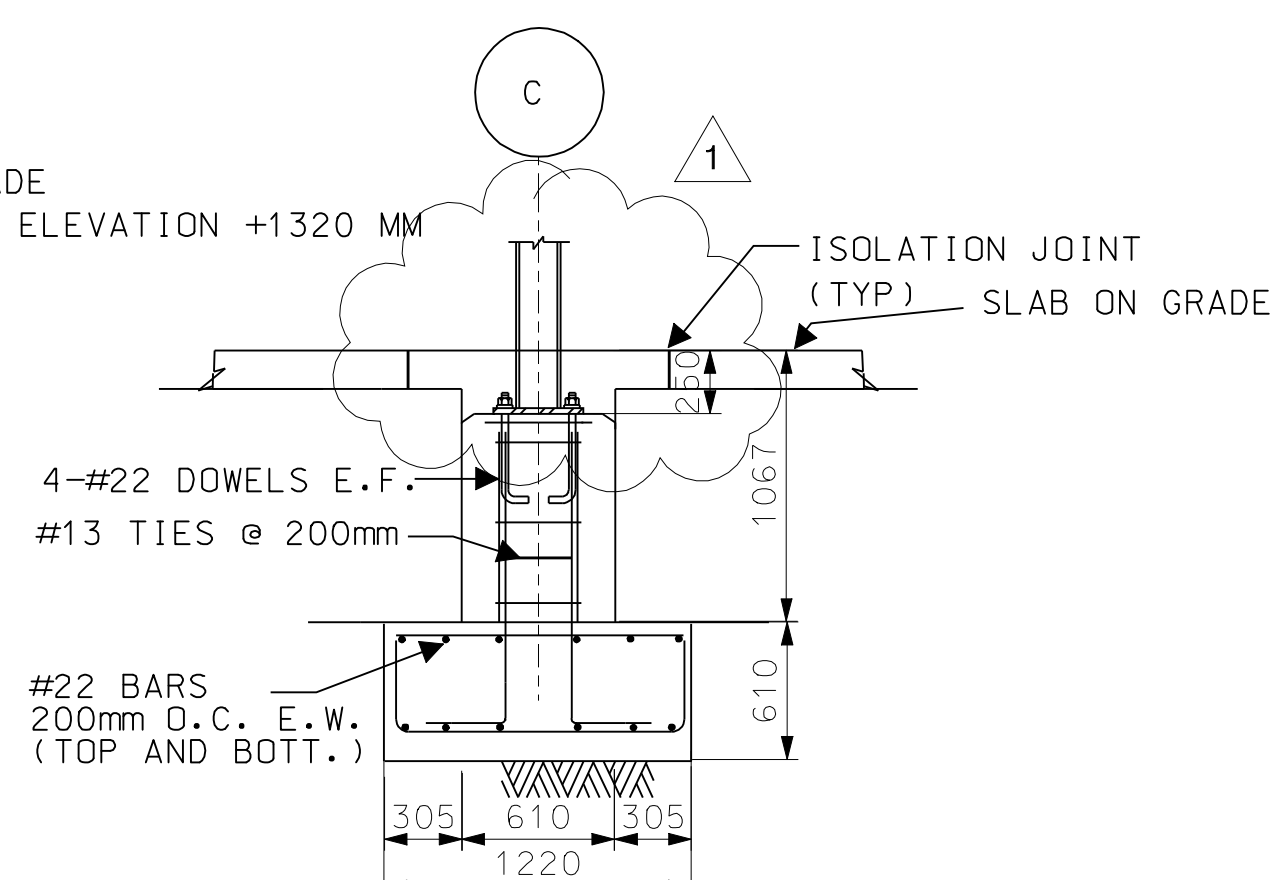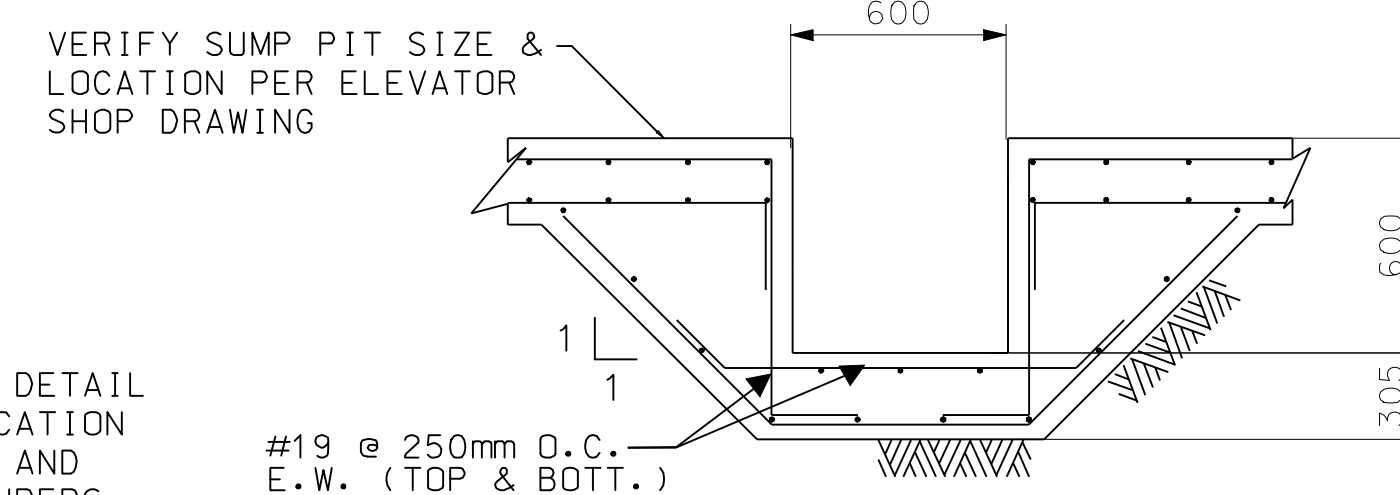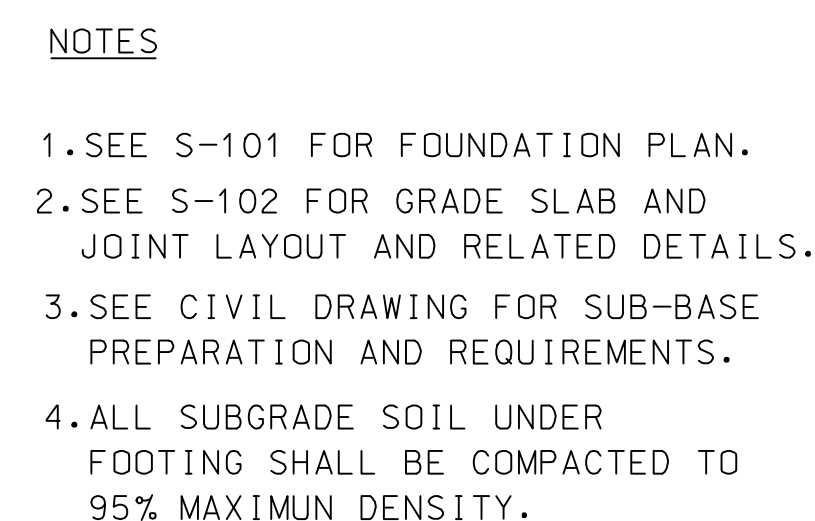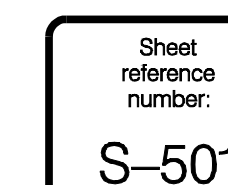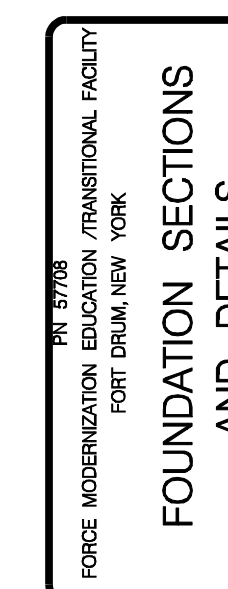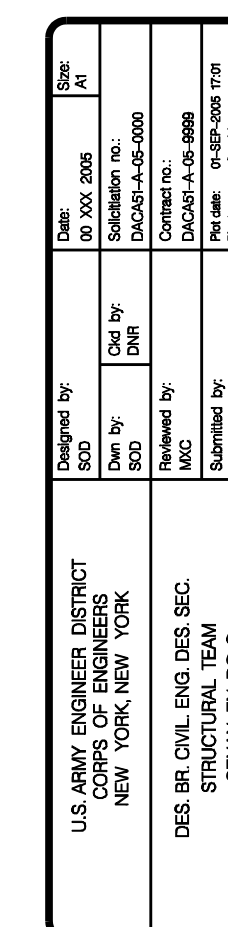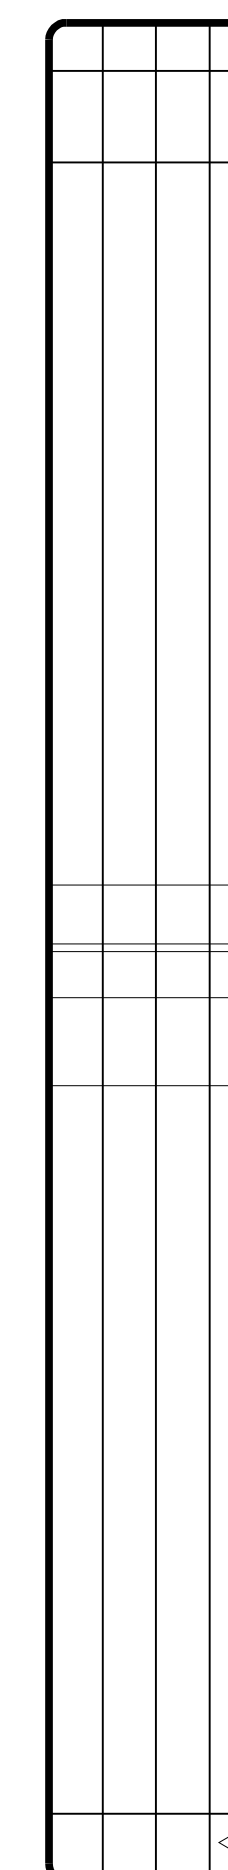


SECTION AT DOCK LEVELER (FOUNDATION TYPE F8)

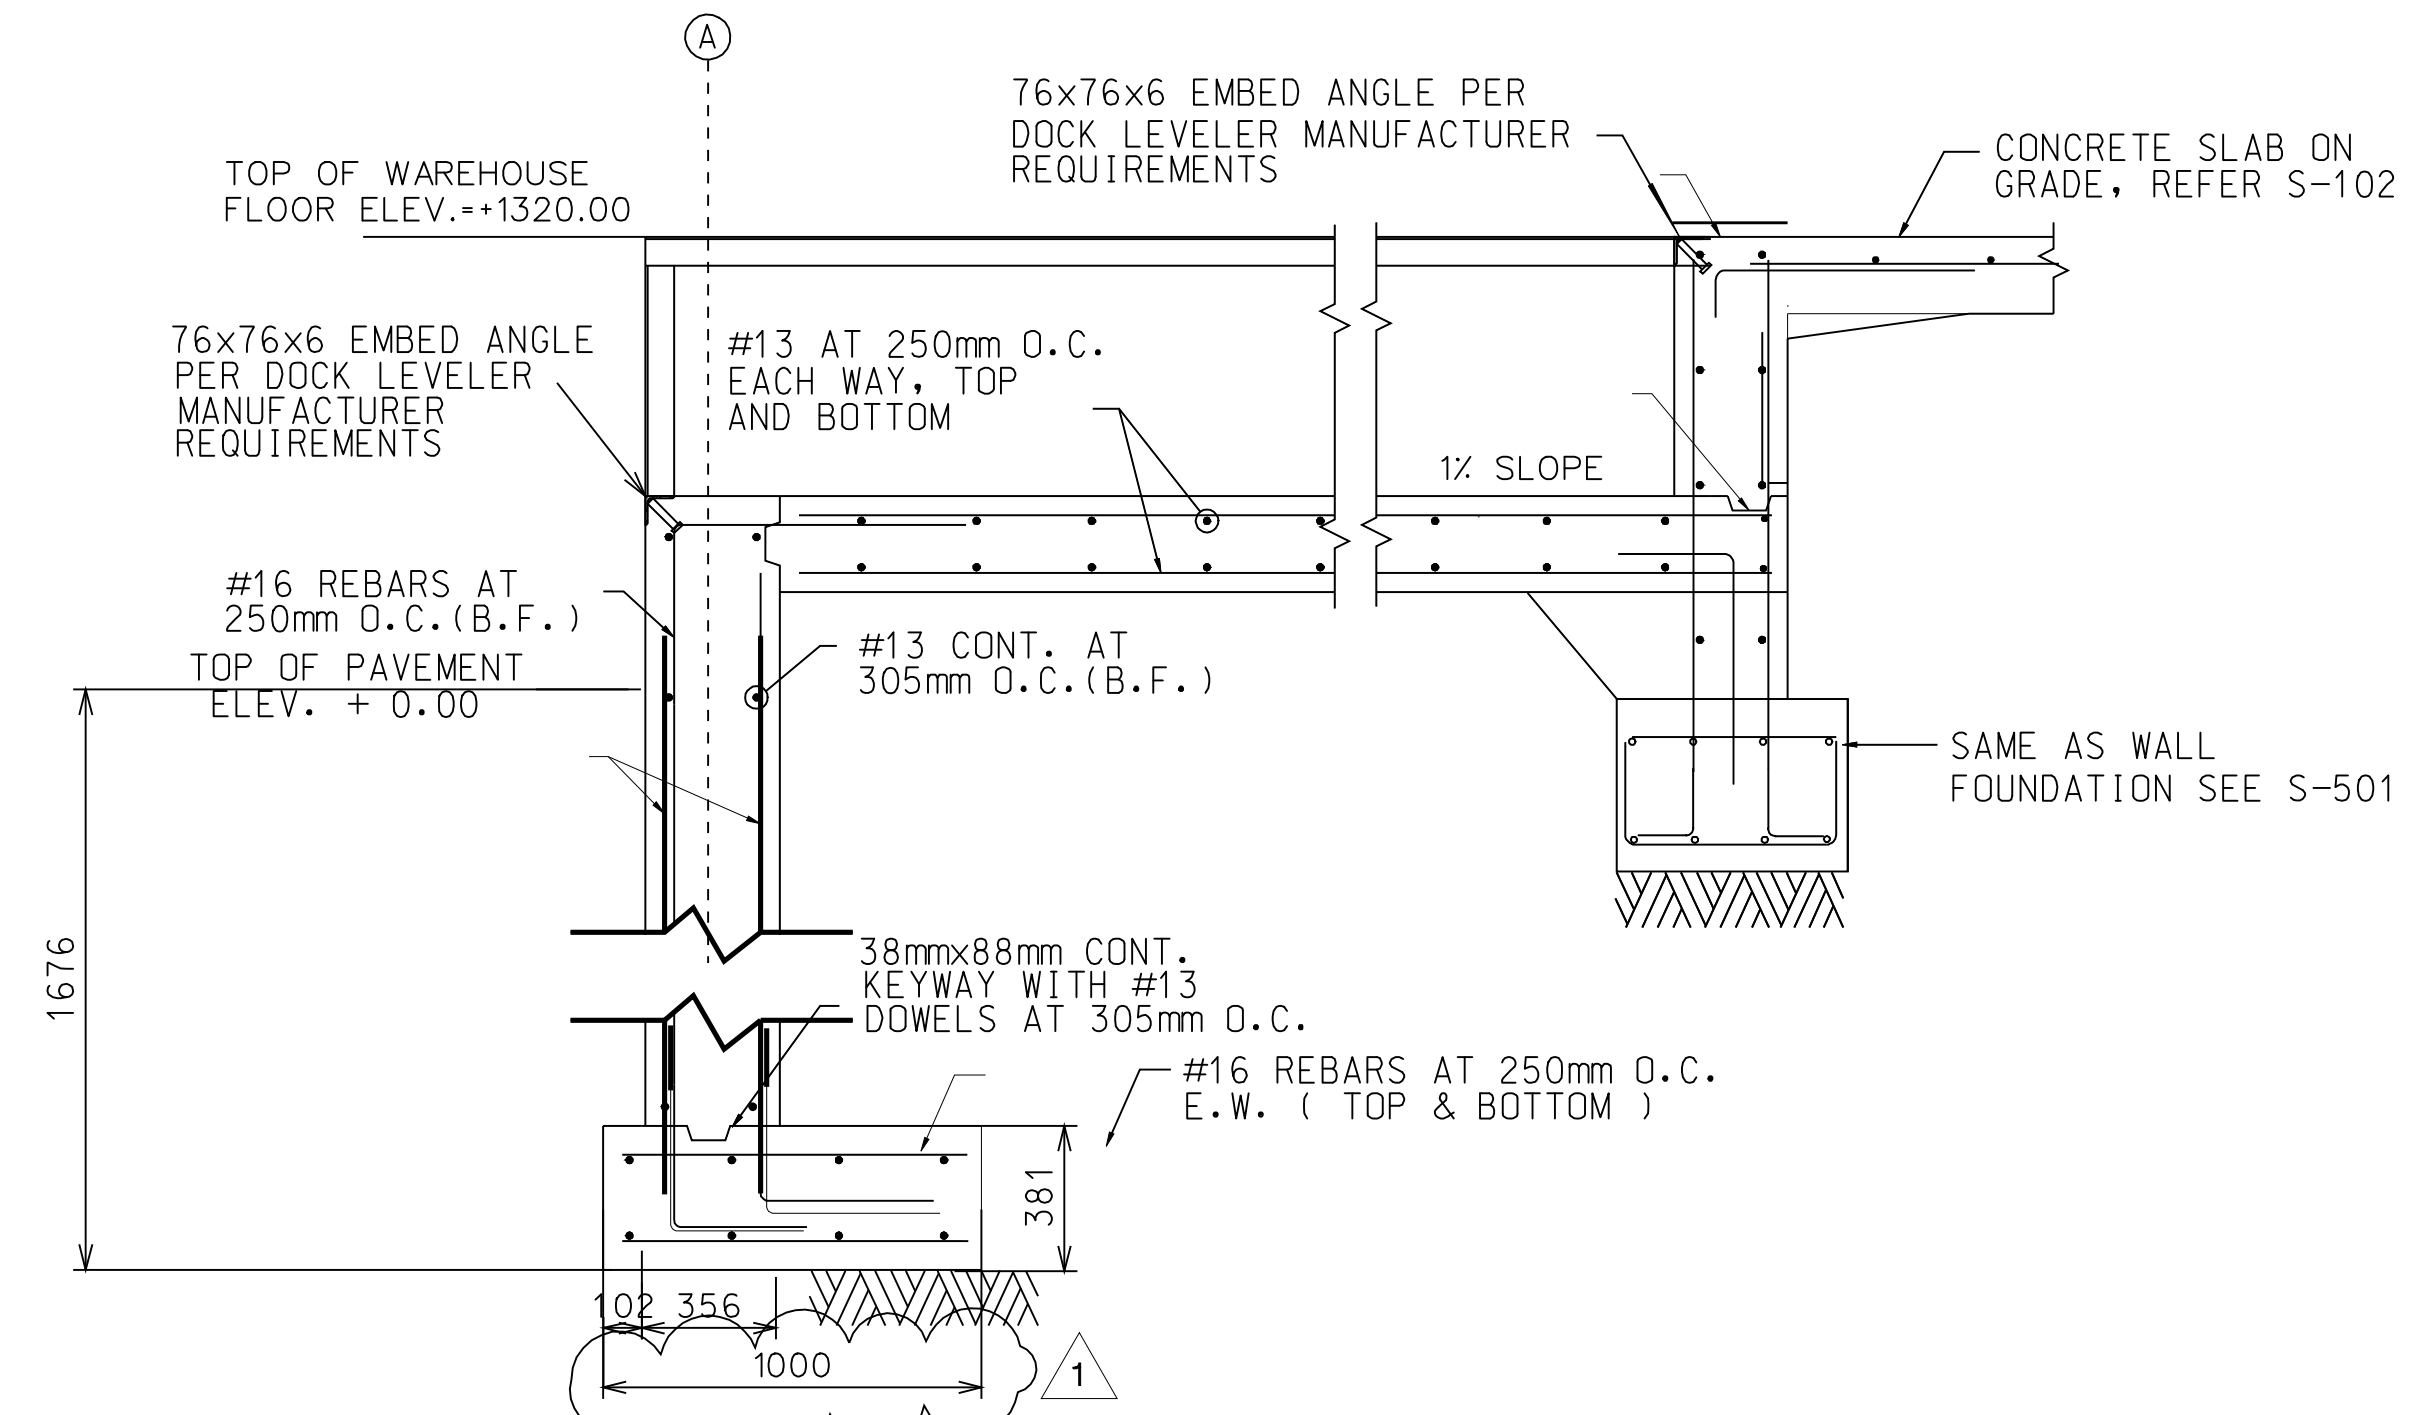


EXTERIOR RAMP SECTION



EXTERIOR STAIR SECTION

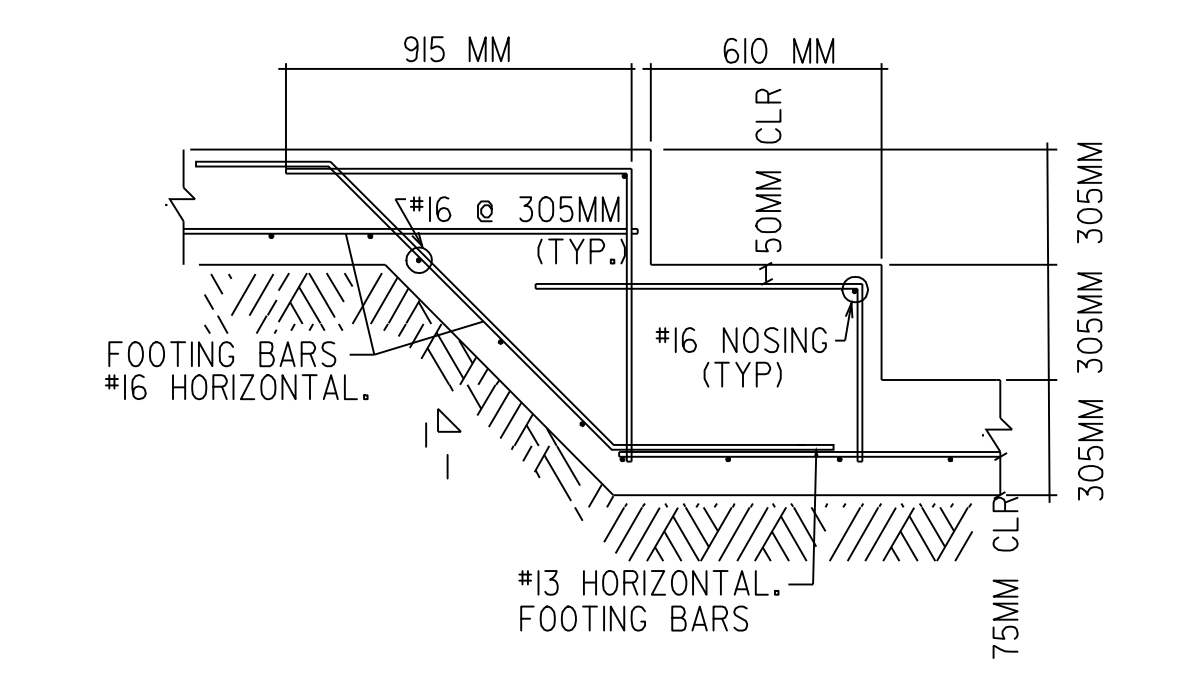


STEPPED REINFORCEMENT DETAIL

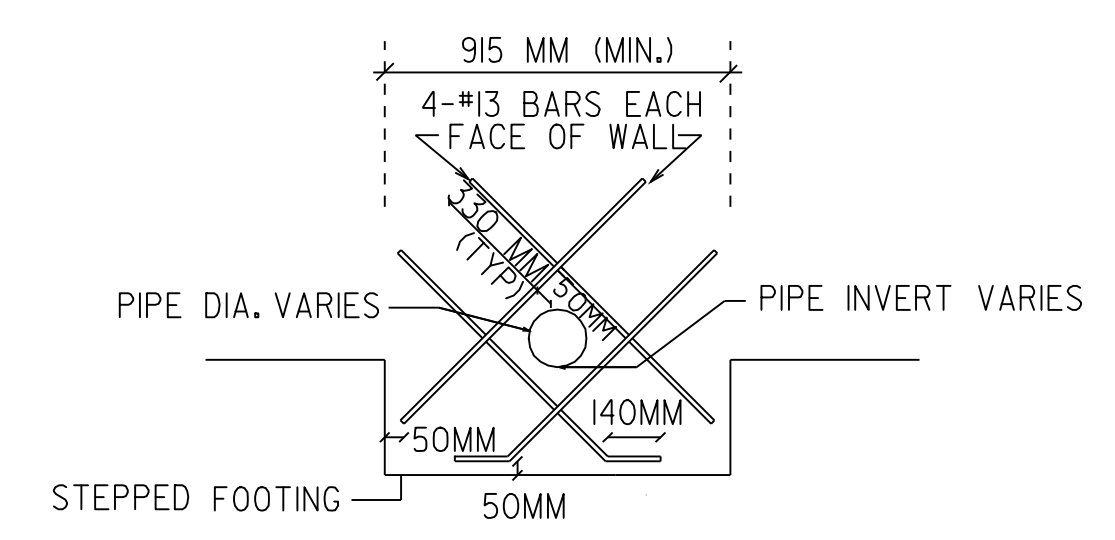

MODIFIED FOUNDATION WALL PENETRATION DETAIL

NOTE: UNDER GROUND UTILITIES SHALL ENTER THE BLDG THRU THE FOUNDATION WALL. THE CONTRACTOR SHALL CALCULATE THE NUMBER OF STEPS IN ORDER TO REACH A SUFFICIENT DEPTH TO CLEAR THE PIPE INVERTS. CALCULATIONS SHALL BE SUBMITTED TO THE RESIDENT ENGINEER FOR APPROVAL.

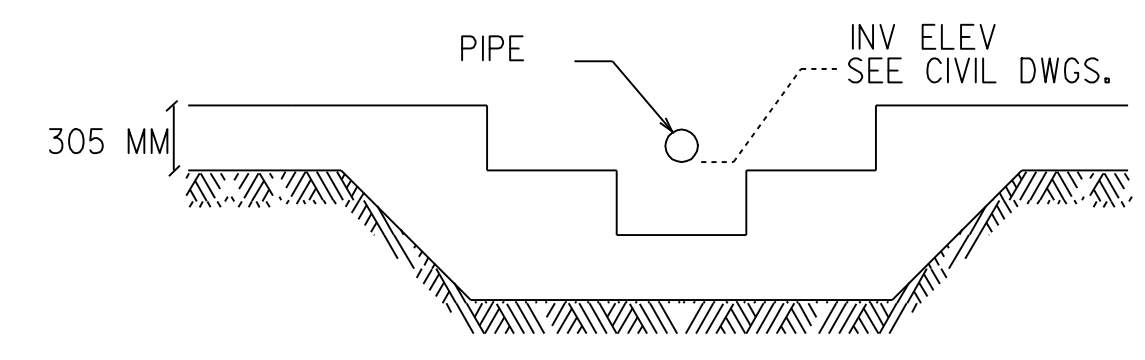

TYPICAL STEP FOOTING DETAIL

NOTES:
1. SEE S-101 FOR FOUNDATION PLAN
2. ALL SUBGRADE SOIL UNDER FOOTING SHALL BE COMPACTED TO 95% MAXIMUM DENSITY.
400 200 0 400 800
SCALE: 1 : 20

US Army Corps of Engineers
New York District

Rev	Date	Description
1	01-SEP-2005	ISSUED FOR CONSTRUCTION

DESIGNED BY: SCD
CHECKED BY: SCD
DATE: 01-SEP-2005

DRAWN BY: SCD
CHECKED BY: SCD
DATE: 01-SEP-2005

PROJECT: FORT DRUM, NEW YORK
SHEET: S-502

FORCES MODERNIZATION EDUCATION / TRANSITIONAL FACILITY
FORT DRUM, NEW YORK

MISCELLANEOUS DETAILS

Sheet reference number:
S-502